ELECTRICAL SYMBOL LIST

<u>Raceways</u>

CONDUIT CONCEALED IN WALL OR CEILING SPACE

CONDUIT/WIRING STUBBED OUT WITH END CAP OR

a THRU z (LOWERCASE) = LUMINAIRE CONTROL

M = MANUAL MOTOR STARTER WITH THERMAL

EXIT SIGN CEILING MOUNTED, ARROW(S) INDICATES

EXIT SIGN WALL MOUNTED, ARROW(S) INDICATES

AREA LUMINAIRE ARM MOUNTED WITH POLE AND

SURFACE OR PENDANT MOUNTED LUMINAIRE CONNECTED

TO EMERGENCY/LIFE SAFETY CIRCUIT OR WITH INTEGRAL EMERGENCY BATTERY CONNECTED TO UNSWITCHED

SURFACE OR PENDANT MOUNTED LUMINAIRE

CONDUIT ROUTED BELOW FLOOR / GRADE

CONDUIT/WIRING CONTINUATION

INSULATÉD PLASTIC BUSHING

CONDUIT ELLED DOWN

_____O CONDUIT ELLED UP

FLEXIBLE CONDUIT

Lighting

Switches and Receptacles

SINGLE POLE SWITCH

DESIGNATION D = DIMMER

OVERLOAD

CEILING FAN

DIRECTION IF SHOWN

DIRECTION IF SHOWN

WALL MOUNTED LUMINAIRE

CONCRETE BASE

2 = DOUBLE POLE SWITCH 3 = THREE-WAY SWITCH 4 = FOUR-WAY SWITCH

F = FAN SPEED CONTROLK = KEY OPERATED SWITCH

P = SWITCH WITH PILOT LIGHT

W = WEATHERPROOF SWITCH
V = LOW VOLTAGE SWITCH
? = DESIGNER DEFINED SWITCH

L = LIGHTED HANDLE


S = SENTRY SWITCH T = INTERVAL TIMER

NOTE: This is a standard symbol list and not all items listed may be used.


А	AMPERES, AMBER					
AC	ALTERNATING CURRENT, AIR CONDITIONER					
AFC	ABOVE FINISHED CEILING					
AFF	ABOVE FINISHED FLOOR					
AFG	ABOVE FINISHED GRADE					
AIC						
AWG	AVAILABLE INTERRUPTING CAPACITY AMERICAN WIRE GAUGE BARE COPPER					
BC						
С	CONDUIT, CLOSE, CONTROL					
	CONDOTT, CLOSE, CONTROL CIRCUIT BREAKER CONTRACTOR FURNISHED CONTRACTOR INSTALLED					
CB						
CFCI						
CFOI	CONTRACTOR FURNISHED OWNER INSTALLED					
CLG	CEILING COMMUNICATION CURRENT TRANSFORMER					
COM						
CU	CORRENT TRANSFORMER					
CU	COPPER					
DN	DOWN EVHALIST FAN					
EF	EXHAUST FAN					
F	FUSE					
FACP						
FB0	FURNISHED BY OTHERS					
G, GND	GROUND					
GFCI	GROUND FAULT DITERRUPTER					
GFI	GROUND FAULT INTERRUPTER					
GRC	GALVANIZED RIGID STEEL CONDUIT					
KVA	KILOVOLT AMPERES					
KW	KILOWATT					
LED	LIGHT EMITTING DIODE					
MDB	MAIN DISTRIBUTION BOARD					
MDP	MAIN DISTRIBUTION PANEL					
MSB	MAIN SWITCHBOARD					
	MOUNT, MOUNTED					
MT	EMPTY CONDUIT WITH NYLON PULL CORD					
N/A	NOT APPLICABLE					
N	NEUTRAL					
NEC						
NEMA	NATIONAL ELECTRICAL MANUFACTURERS ASSOCIATION					
OFCI	OWNER FURNISHED, CONTRACTOR INSTALLED					
OFOI	OWNER FURNISHED, OWNER INSTALLED					
OS	OCCUPANCY SENSOR					
PH	PHASE					
PNL	PANEL					
REF	REFERENCE					
REQD	REQUIRED					
S	SWITCH					
SIM	SIMILAR					
TELE	TELEPHONE					
TTB	TELEPHONE TERMINAL BOARD					
TYP	TYPICAL					
UL	UNDERWRITERS LABORATORIES					
UON	UNLESS OTHERWISE NOTED					
V	VOLTS, VOLTAGE					


WEATHERPROOF

	LIGHTING FIXTURE SCHEDULE								
TAG	MANUFACTURER	DESCRIPTION	LAMPS	WATTS	COLOR	MOUNTING			
Α	LITHONIA #FMLL-9-30840	4' CLOUD WRAPAROUND LED AREA LIGHTING FIXTURE	LED BY MFR	36	WH	SURFACE			
_	HD SUPPLY #326867	LED DRUM LIGHT	LED BY MFR	18	NKL	SURFACE			
_	WAC "MODERN FORMS" #WS-3624-BN	LED WALL BRACKET AT VANITY	LED BY MFR	22	NKL	SURFACE-WALL			
	GOOD EARTH LIGHTING #SE1018-BRM-01LFO-U	EXTERIOR LED MINI WALLPACK	LED BY MFR	10	BRZ	SURFACE-WALL			
	LITHONIA #TWR1-LED-1-50K-MVOLT-PE	EXTERIOR LED WALLPACK WITH INTEGRAL PHOTOCELL	LED BY MFR	31	DBZ	SURFACE-WALL			
F	ADDRESS-O-LITE WITH CUSTOM VERTICAL ADDRESS MARK TELEPHONE 800-843-5483	EXTERIOR LED-ILLUMINATED UNIT ADDRESS SIGN	LED BY MFR	6	BLK	VERTICALLY MOUNTED SURFACE-WALL OVER NEW FLUSH OUTLET BOX			
	NOT USED								
	NOT USED								

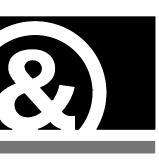

monighandesig 710 twelfth street sacramento, ca 95814 telephone: 916.448.1901 fascimile: 916.448.5401 www.monighan.com

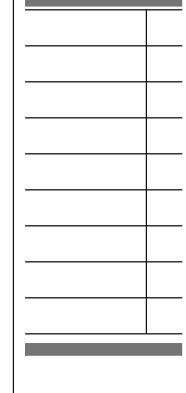

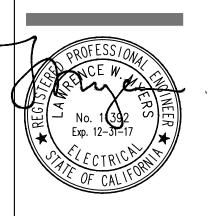



ELEC'L SYMBOLS & FIXTURE SCHEDUL


RICHLAND HOUSING PHASE II

DEVELPMENT 1, BUILDING TYPES 'A', 'B' & 'C'

REHABILITATION & IMPROVEMENTS

DATE **11/24/2016**DRAWN BY **GS/NN/KD**JOB **15002-000**

E0.1

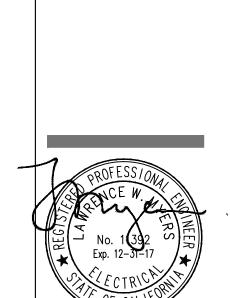

Stanton
ENGINEERING W+E

PROJECT 15073

1819 K Street, Suite 250
Sacramento, CA 95811

ENGINEERING (M) +

PROJECT 15073


1819 K Street, Suite 250
Sacramento, CA 95811
TEL 916.288.6250
www.stantoneng.com


LECTRICAL SITE PLA

RICHLAND HOUSING PHASE II
DEVELPMENT 1, BUILDING TYPES 'A', 'B' & 'C'
REHABILITATION & IMPROVEMENTS


DATE **11/24/2016**DRAWN BY **GS/NN/KD**JOB **15002-000**

E1.0

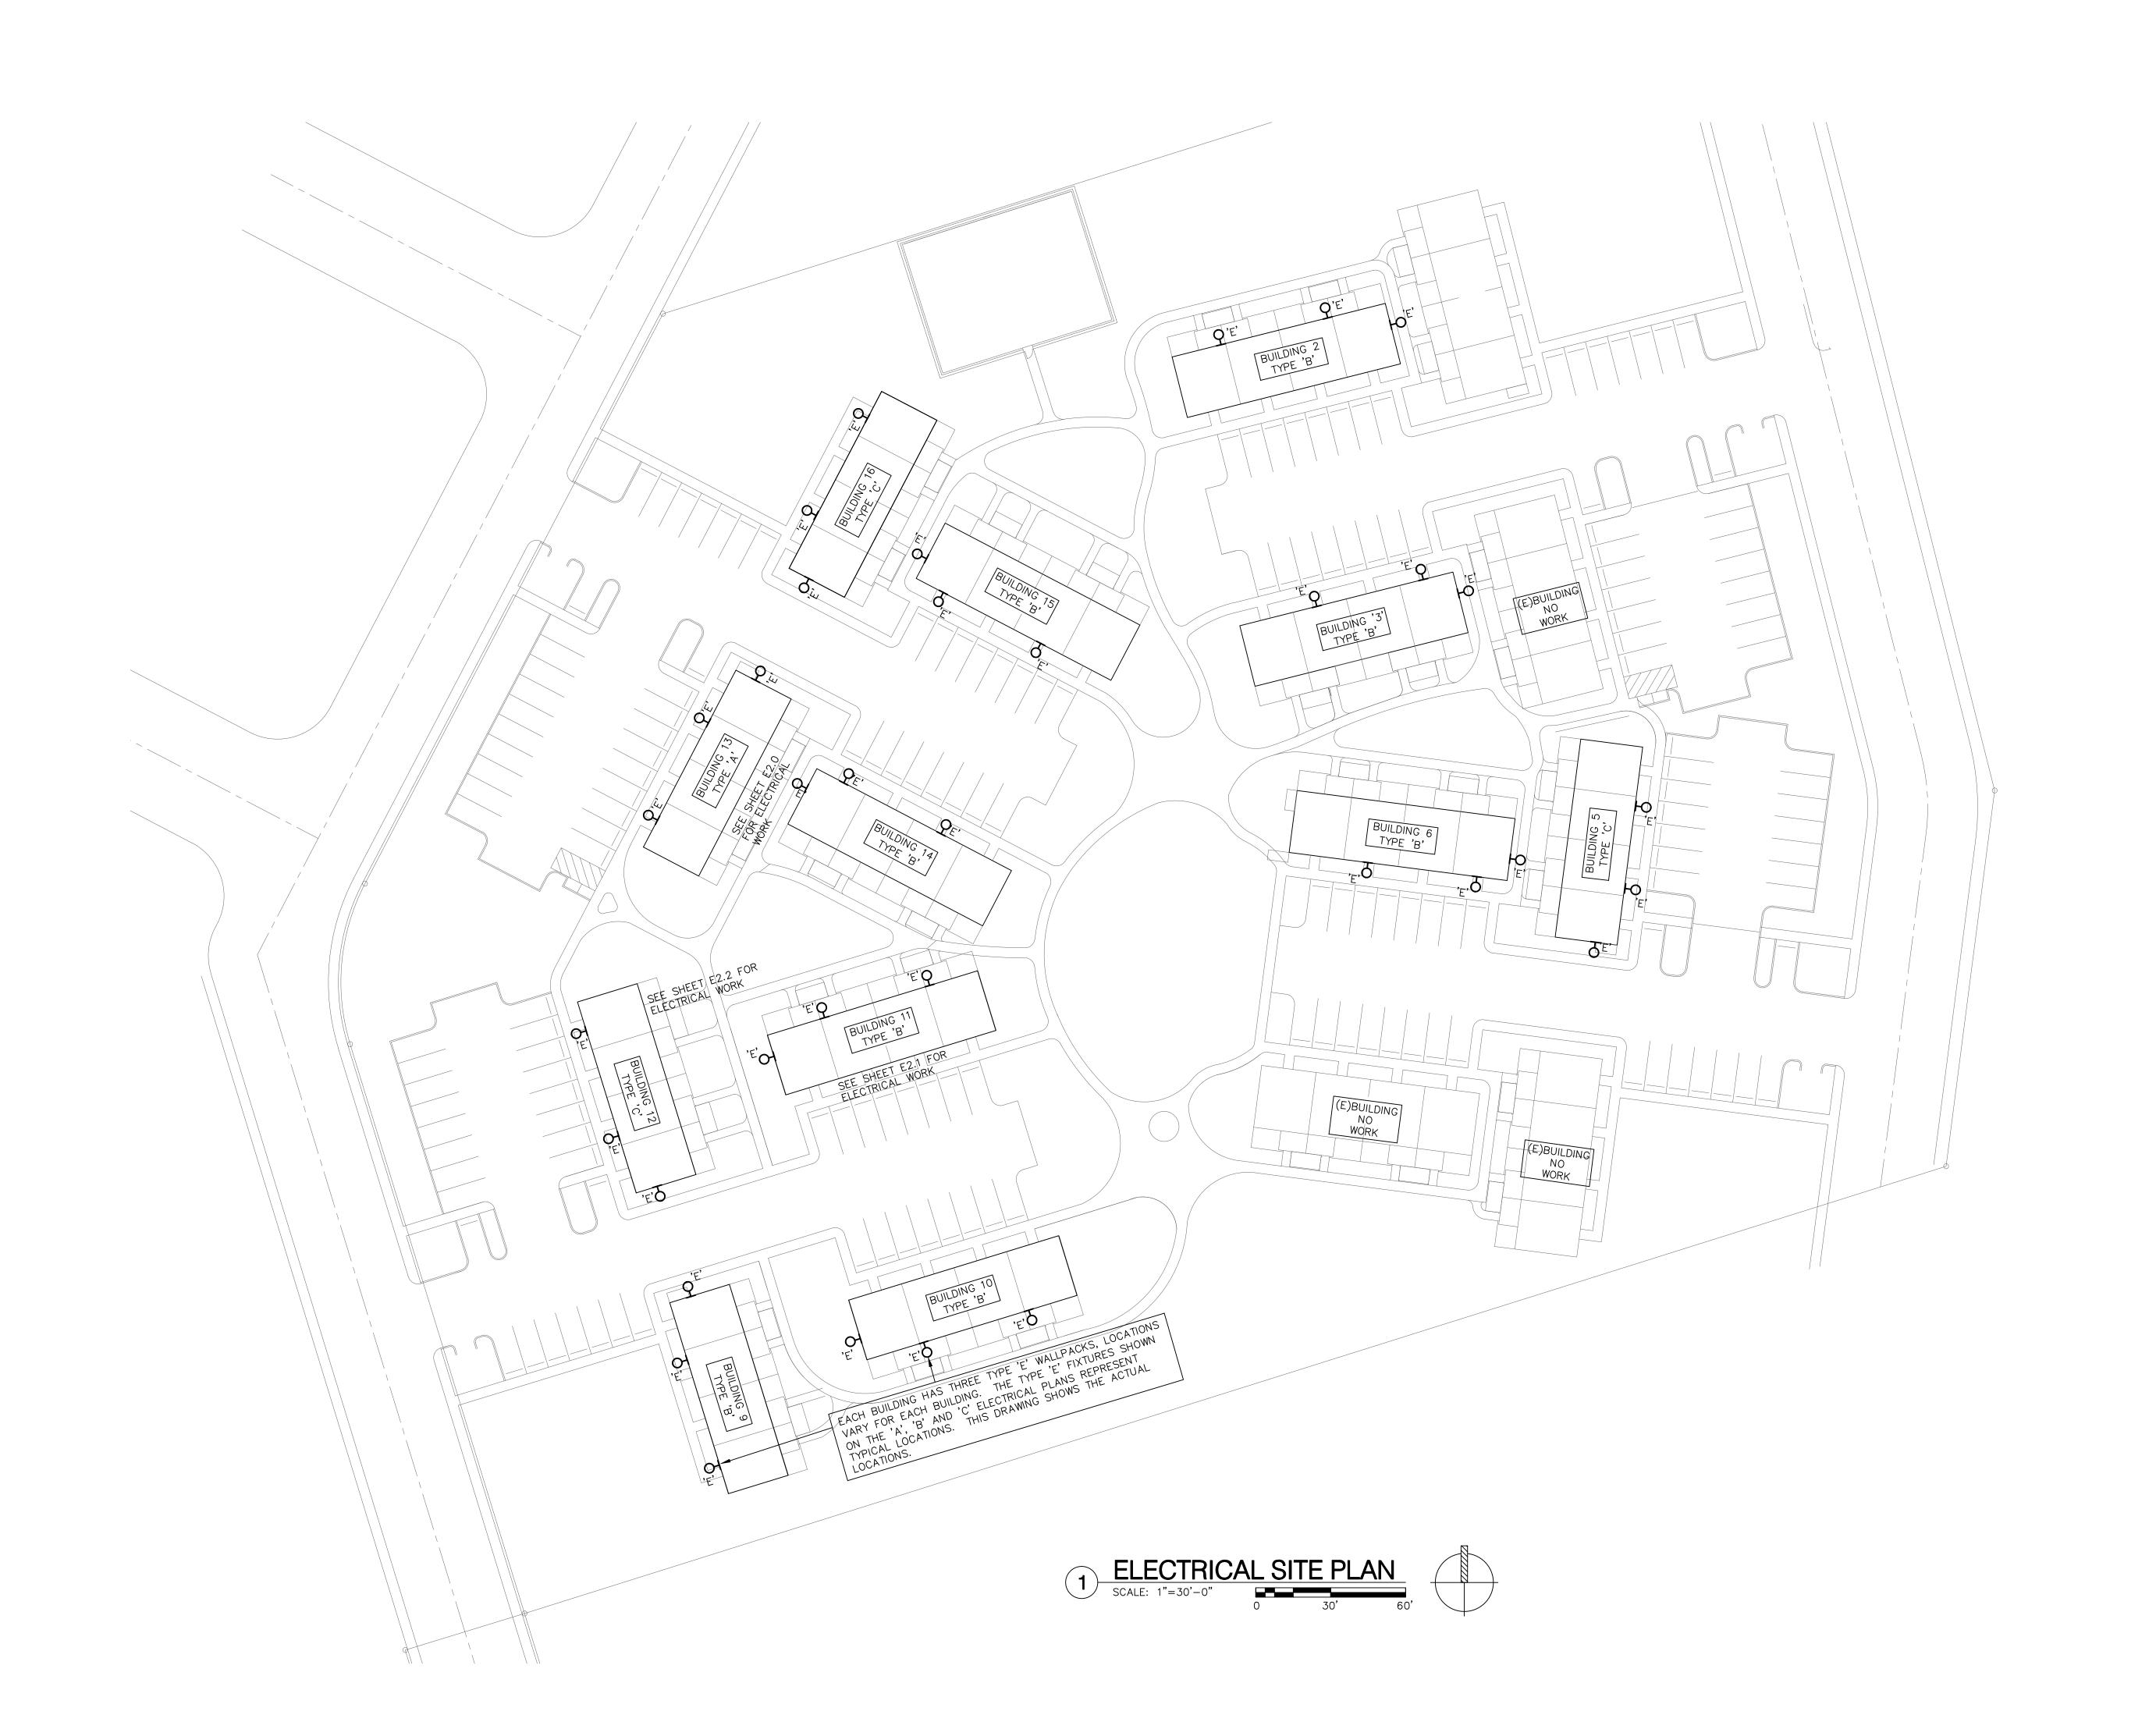

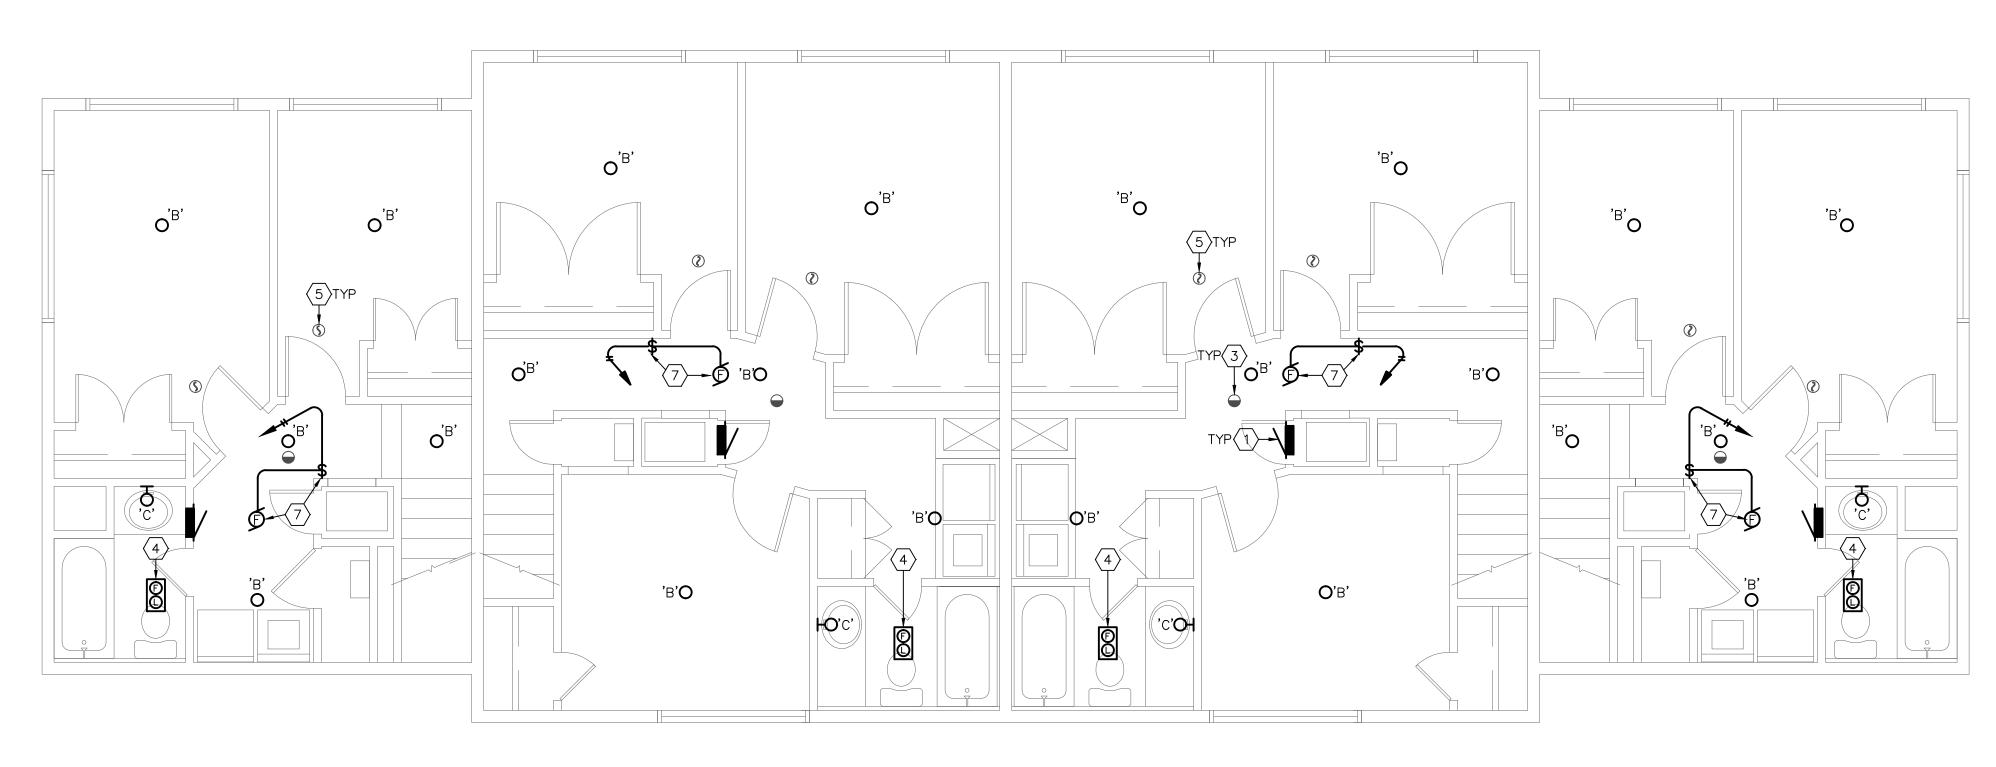

BUILDING A SECOND FLOOR ELECTRICAL PLAN SCALE: 1/4"=1'-0" 0 2' 4' 8'

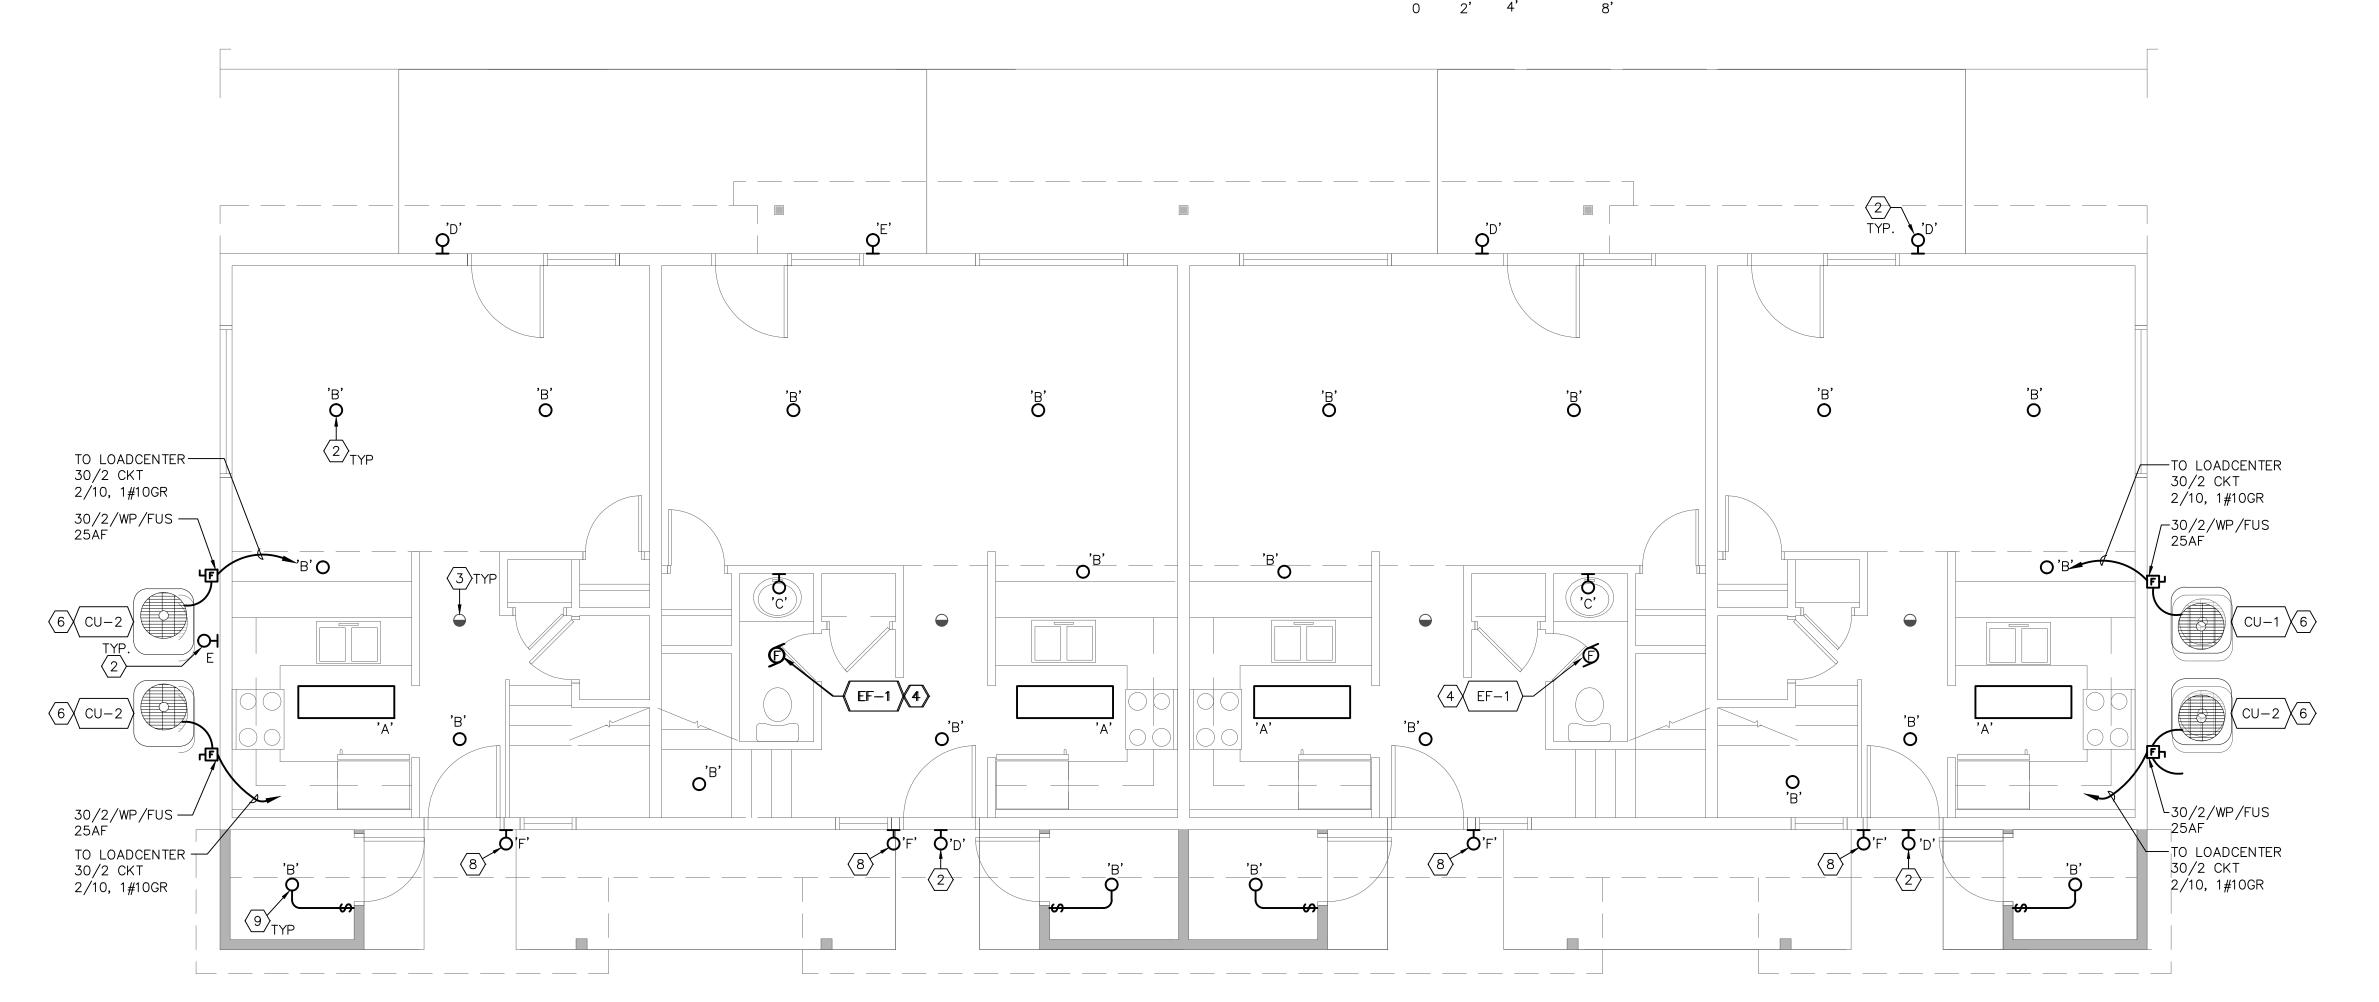

BUILDING A FIRST FLOOR ELECTRICAL PLAN
SCALE: 1/4"=1'-0"

O 2' 4' 8'

○ SHEET KEYNOTES

- 1 (E) 100A 120/240V 10 LOADCENTER TO REMAIN WITH MODIFICATION: PROVIDE NEW 20/1 SQUARE D "QO" BREAKER AT AVAILABLE SPACE AT BOTTOM OF LOADCENTER. THIS NEW CIRCUIT BREAKER WILL SERVE THE NEW FAN BLOWER AND THE NEW WHOLE HOUSE EXHAUST FAN.
- 2 APPROXIMATE LOCATION OF AN EXISTING LIGHTING FIXTURE TO BE REPLACED WITH A NEW AS SCHEDULED. DISCONNECT AND REMOVE THE (E) FIXTURE AND RELATED LAMPS. PROVIDE NEW FIXTURE PER SCHEDULE WITHOUT SUBSTITUTION.
- 3 PROVIDE NEW COMBINATION SMOKE AND CARBON MONOXIDE SENSOR APPROXIMATELY WHERE SHOWN. CONNECT TO NEAREST UNSWITCHED GENERAL LIGHTING CIRCUIT.
- 4 CONNECT NEW EXHAUST FAN THAT REPLACES EXISTING FAN. RE—USE EXISTING BRANCH CIRCUITING. FAN FURNISHED/INSTALLED BY HVAC.
- 5 PROVIDE NEW SMOKE SENSOR APPROXIMATELY WHERE SHOWN. CONNECT TO NEAREST UNSWITCHED GENERAL LIGHTING CIRCUIT.
- 6 CONNECT NEW HVAC CONDENSER UNIT. PROVIDE WEATHERPROOF FUSIBLE DISCONNECT SWITCH AND FEEDER; RUN FEEDER CONDUIT AND WIRE EXPOSED


TO SECOND FLOOR ATTIC ($\frac{1}{2}$ " - 2#10, #10 GROUND) AND THEN 10/2 PLUS

- GROUND TYPE 'NM' FEEDER TO (E) FEEDER BREAKER AT LOADCENTER.

 7 CONNECT 550 WATT WHOLE HOUSE FAN MOTOR IN CEILING SPACE. PROVIDE SPST RATED MOTOR SWITCH AT +48" TO CONTROL FAN.
- 8 PROVIDE INTERNALLY—ILLUMINATED ADDRESS SIGN BETWEEN DOOR JAMB AND WINDOW LIGHT, AND CONNECT TO NEAREST UNSWITCHED GENERAL LIGHTING BRANCH CIRCUIT AS REQUIRED. OBTAIN ADDRESS NOMEMCLATURE FROM
- 9. PROVIDE NEW LIGHT FIXTURE AND SWITCH, APPROXIMATELY WHERE SHOWN. CONNECT TO NEAREST UNSWITCHED GENERAL LIGHTING CIRCUIT.





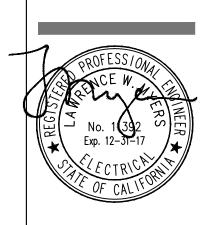

PROJECT 15073
1819 K Street, Suite 250
Sacramento, CA 95811
TEL 916.288.6250
www.stantoneng.com

BUILDING 'A' LECTRICAL PLANS


RICHLAND HOUSING PHASE II
DEVELPMENT 1, BUILDING TYPES 'A', 'B' & 'C'
REHABILITATION & IMPROVEMENTS

DATE 11/24/2016


DRAWN BY GS/NN/KD

JOB 15002-000

E2.0

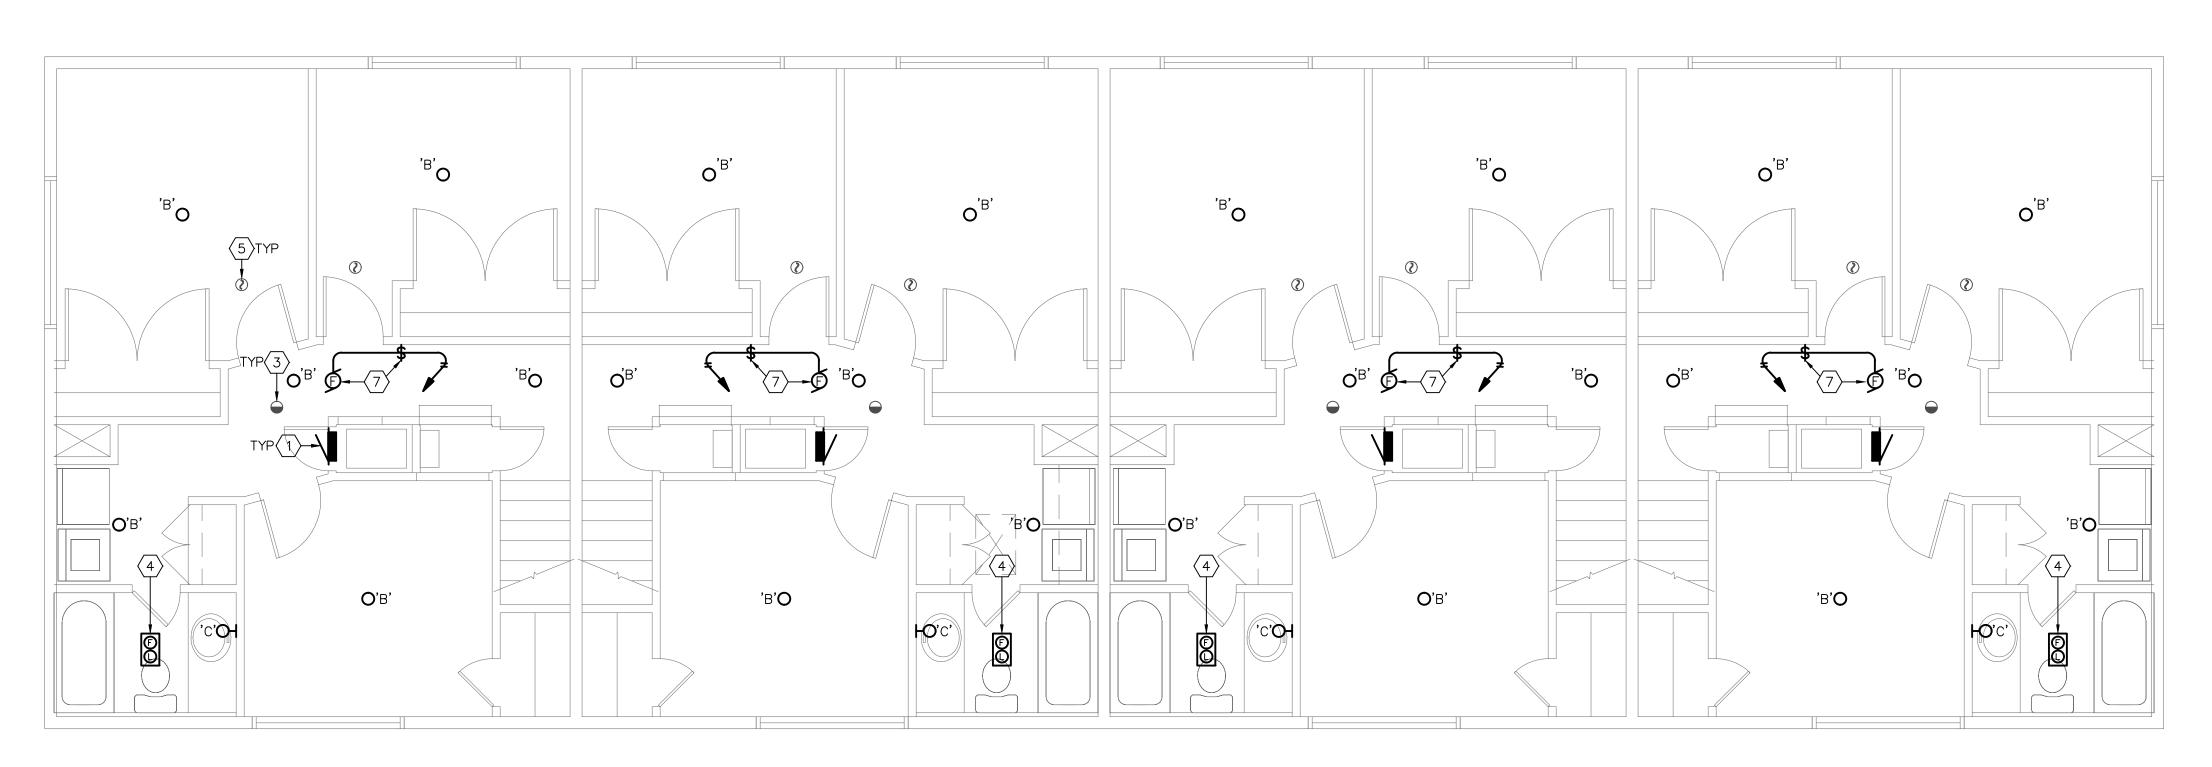

BUILDING B SECOND FLOOR ELECTRICAL PLAN SCALE: 1/4"=1'-0" 0 2' 4' 8'

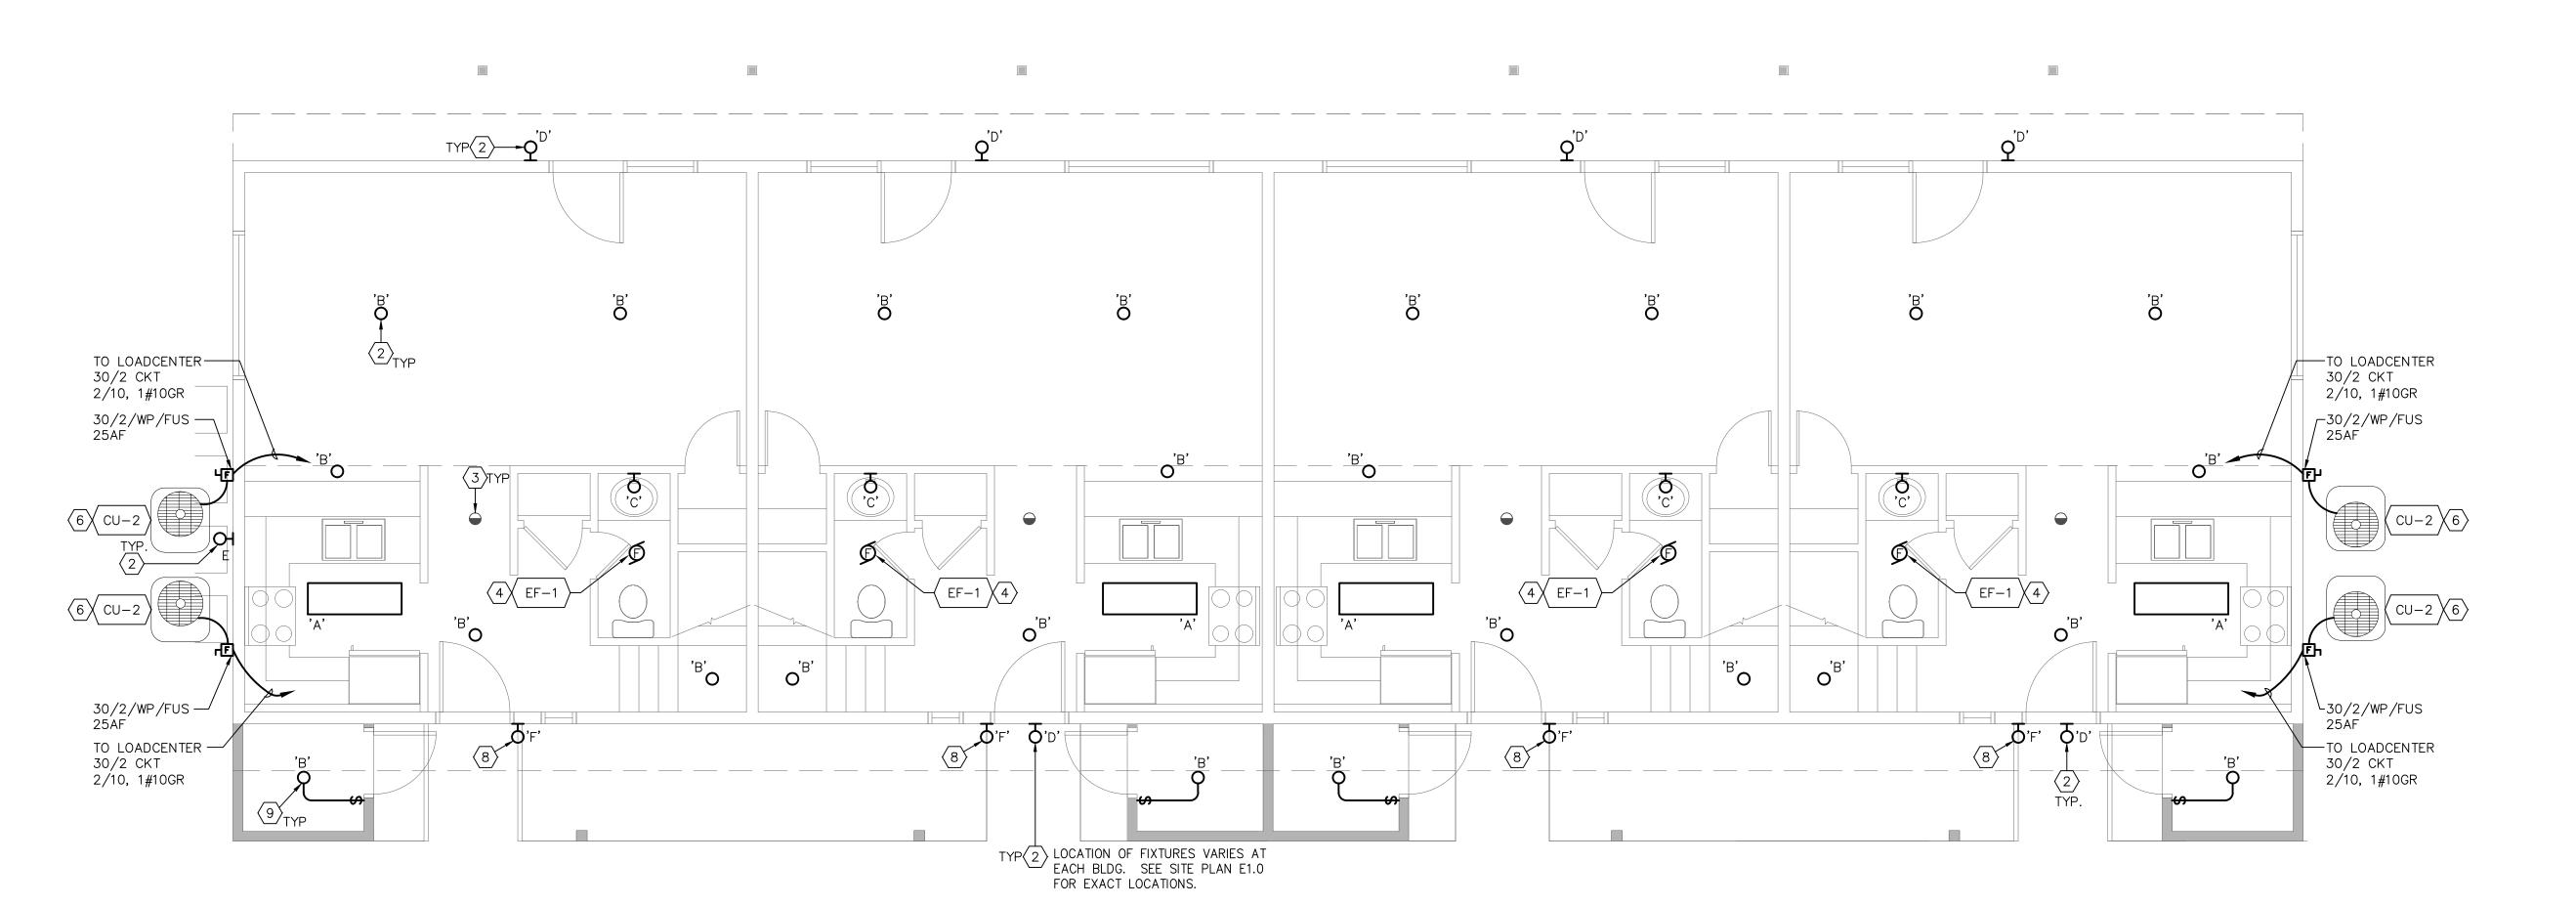

BUILDING B FIRST FLOOR ELECTRICAL PLAN SCALE: 1/4"=1'-0" O 2' 4' 8'

○ SHEET KEYNOTES

- 1 (E) 100A 120/240V 10 LOADCENTER TO REMAIN WITH MODIFICATION: PROVIDE NEW 20/1 SQUARE D "QO" BREAKER AT AVAILABLE SPACE AT BOTTOM OF LOADCENTER. THIS NEW CIRCUIT BREAKER WILL SERVE THE NEW FAN BLOWER AND THE NEW WHOLE HOUSE EXHAUST FAN.
- APPROXIMATE LOCATION OF AN EXISTING LIGHTING FIXTURE TO BE REPLACED WITH A NEW AS SCHEDULED. DISCONNECT AND REMOVE THE (E) FIXTURE AND RELATED LAMPS. PROVIDE NEW FIXTURE PER SCHEDULE WITHOUT SUBSTITUTION.
- 3 PROVIDE NEW COMBINATION SMOKE AND CARBON MONOXIDE SENSOR APPROXIMATELY WHERE SHOWN. CONNECT TO NEAREST UNSWITCHED GENERAL LIGHTING CIRCUIT.
- 4 CONNECT NEW EXHAUST FAN THAT REPLACES EXISTING FAN. RE—USE EXISTING BRANCH CIRCUITING. FAN FURNISHED/INSTALLED BY HVAC.
- 5 PROVIDE NEW SMOKE SENSOR APPROXIMATELY WHERE SHOWN. CONNECT TO NEAREST UNSWITCHED GENERAL LIGHTING CIRCUIT.
- 6 CONNECT NEW HVAC CONDENSER UNIT. PROVIDE WEATHERPROOF FUSIBLE DISCONNECT SWITCH AND FEEDER; RUN FEEDER CONDUIT AND WIRE EXPOSED


TO SECOND FLOOR ATTIC (1/2" - 2#10, #10 GROUND) AND THEN 10/2 PLUS

- GROUND TYPE 'NM' FEEDER TO (E) FEEDER BREAKER AT LOADCENTER.

 7 CONNECT 550 WATT WHOLE HOUSE FAN MOTOR IN CEILING SPACE. PROVIDE SPST RATED MOTOR SWITCH AT +48" TO CONTROL FAN.
- 8 PROVIDE INTERNALLY—ILLUMINATED ADDRESS SIGN BETWEEN DOOR JAMB AND WINDOW LIGHT, AND CONNECT TO NEAREST UNSWITCHED GENERAL LIGHTING BRANCH CIRCUIT AS REQUIRED. OBTAIN ADDRESS NOMEMCLATURE FROM
- 9. PROVIDE NEW LIGHT FIXTURE AND SWITCH, APPROXIMATELY WHERE SHOWN. CONNECT TO NEAREST UNSWITCHED GENERAL LIGHTING CIRCUIT.





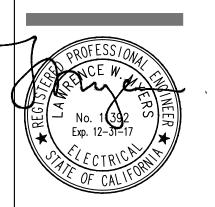

Stanton ENGINEERING W+E PROJECT 15073 1819 K Street. Suite 250

PROJECT 15073
1819 K Street, Suite 250
Sacramento, CA 95811
TEL 916.288.6250
www.stantoneng.com

BUILDING 'B' ELECTRICAL PLANS


RICHLAND HOUSING PHASE II
DEVELPMENT 1, BUILDING TYPES 'A', 'B' & 'C'
REHABILITATION & IMPROVEMENTS

DATE 11/24/2016


DRAWN BY GS/NN/KD

JOB 15002-000

E2.1

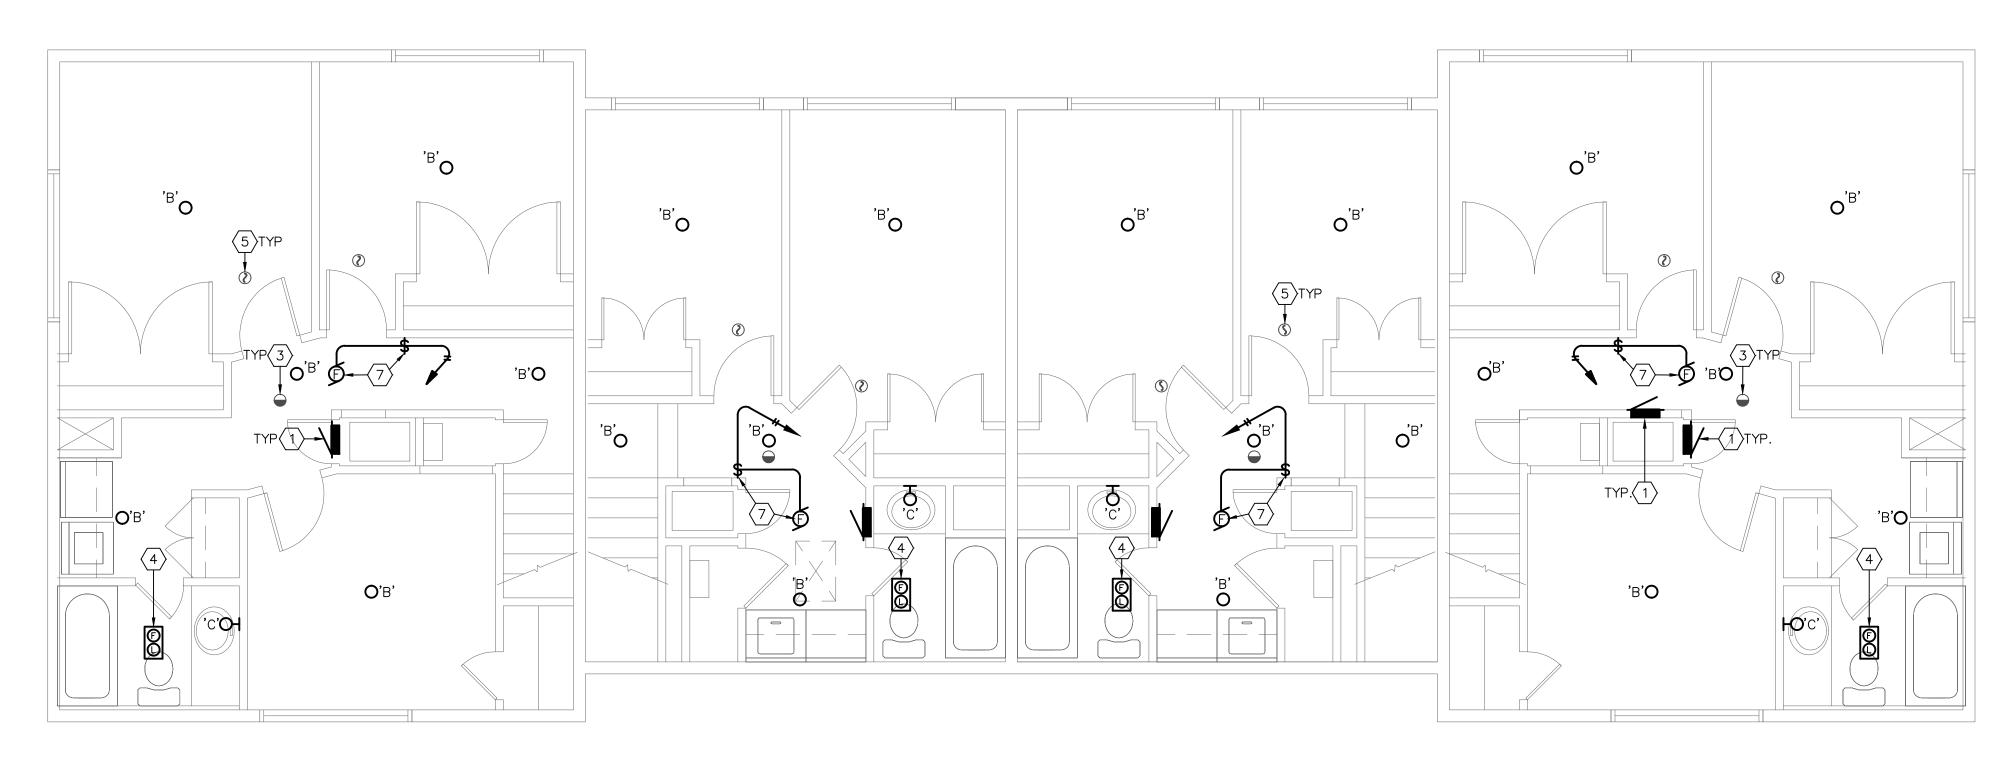

BUILDING C SECOND FLOOR ELECTRICAL PLAN SCALE: 1/4"=1'-0" 0 2' 4' 8'

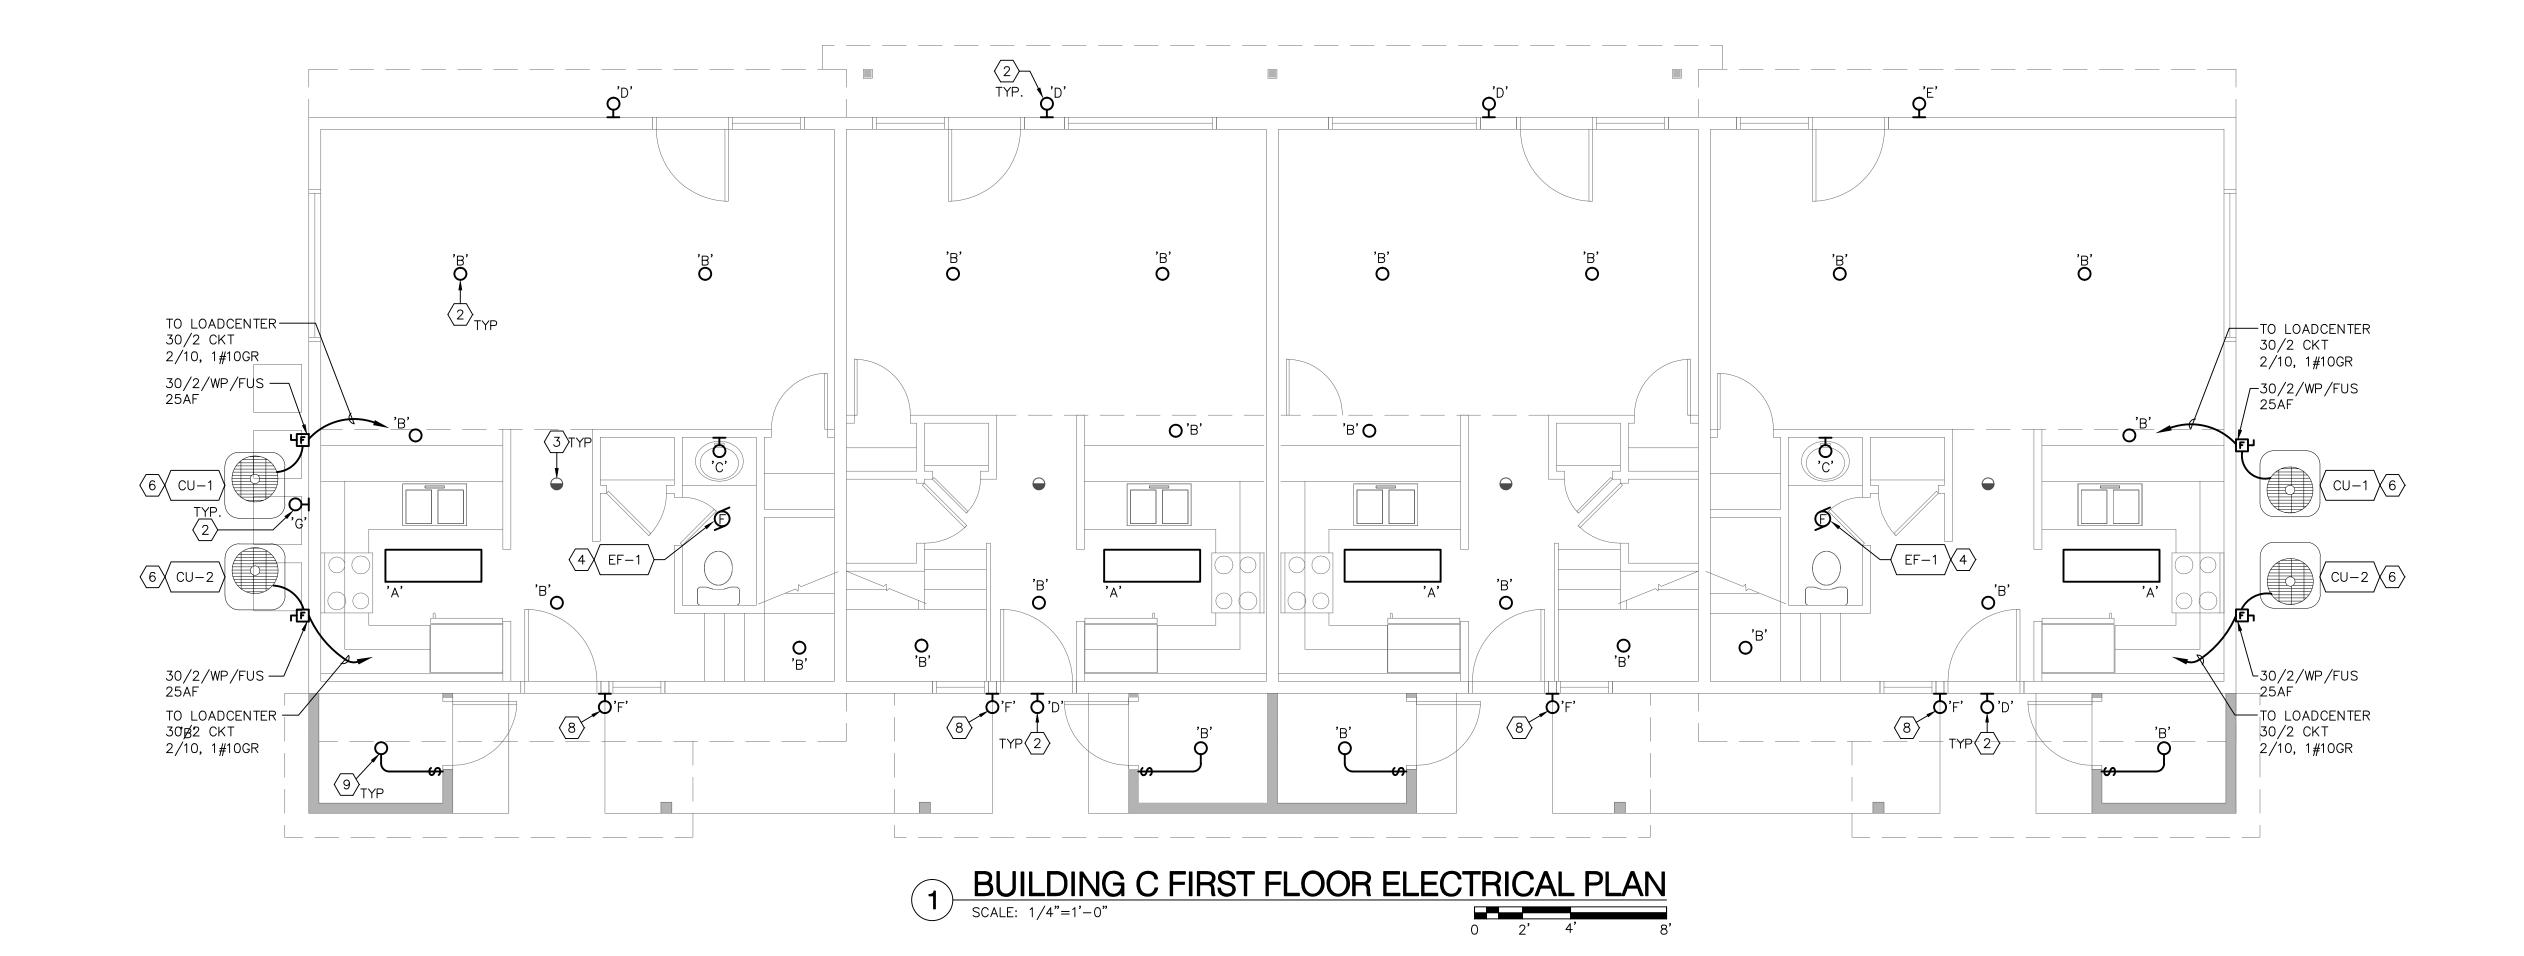


○ SHEET KEYNOTES

- 1 (E) 100A 120/240V 1Ø LOADCENTER TO REMAIN WITH MODIFICATION: PROVIDE NEW 20/1 SQUARE D "QO" BREAKER AT AVAILABLE SPACE AT BOTTOM OF LOADCENTER. THIS NEW CIRCUIT BREAKER WILL SERVE THE NEW FAN BLOWER AND THE NEW WHOLE HOUSE EXHAUST FAN.
- APPROXIMATE LOCATION OF AN EXISTING LIGHTING FIXTURE TO BE REPLACED WITH A NEW AS SCHEDULED. DISCONNECT AND REMOVE THE (E) FIXTURE AND RELATED LAMPS. PROVIDE NEW FIXTURE PER SCHEDULE WITHOUT SUBSTITUTION.
- 3 PROVIDE NEW COMBINATION SMOKE AND CARBON MONOXIDE SENSOR APPROXIMATELY WHERE SHOWN. CONNECT TO NEAREST UNSWITCHED GENERAL LIGHTING CIRCUIT.
- CONNECT NEW EXHAUST FAN THAT REPLACES EXISTING FAN. RE—USE EXISTING BRANCH CIRCUITING. FAN FURNISHED/INSTALLED BY HVAC.
 PROVIDE NEW SMOKE SENSOR APPROXIMATELY WHERE SHOWN. CONNECT TO NEAREST UNSWITCHED GENERAL LIGHTING CIRCUIT.
- 6 CONNECT NEW HVAC CONDENSER UNIT. PROVIDE WEATHERPROOF FUSIBLE DISCONNECT SWITCH AND FEEDER; RUN FEEDER CONDUIT AND WIRE EXPOSED TO SECOND FLOOR ATTIC (½" 2#10, #10 GROUND) AND THEN 10/2 PLUS GROUND TYPE 'NM' FEEDER TO (E) FEEDER BREAKER AT LOADCENTER.
- 7 CONNECT 550 WATT WHOLE HOUSE FAN MOTOR IN CEILING SPACE. PROVIDE SPST RATED MOTOR SWITCH AT +48" TO CONTROL FAN.
- PROVIDE INTERNALLY—ILLUMINATED ADDRESS SIGN BETWEEN DOOR JAMB AND WINDOW LIGHT, AND CONNECT TO NEAREST UNSWITCHED GENERAL LIGHTING BRANCH CIRCUIT AS REQUIRED. OBTAIN ADDRESS NOMEMCLATURE FROM OWNER.
- 9. PROVIDE NEW LIGHT FIXTURE AND SWITCH, APPROXIMATELY WHERE SHOWN. CONNECT TO NEAREST UNSWITCHED GENERAL LIGHTING CIRCUIT.





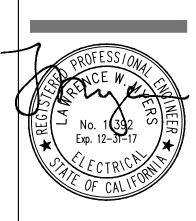

PROJECT 15073

1819 K Street, Suite 250
Sacramento, CA 95811
TEL 916.288.6250
www.stantoneng.com

BUILDING 'C' ECTRICAL PLANS

RICHLAND HOUSING PHASE II
DEVELPMENT 1, BUILDING TYPES 'A', 'B' & 'C'
REHABILITATION & IMPROVEMENTS

DATE **11/24/2016**DRAWN BY **GS/NN/KD**

JOB **15002-000**

E2.2